

PROJECT

**Ballynahone**  
**Long Duration**  
**Energy Storage**

CLIENT



CONSULTANTS




NOTES: -


1. Layout and Arrangements of Substation Building and Electrical Equipment is shown indicatively and for illustration purposes only.
2. Dimensions shown are as per current EirGrid Specifications at the time of submission. Dimensions may vary at time of construction to reflect any revisions to EirGrid Specifications.
3. Final Specifications of Buildings and Electrical Equipment is to be as per Eirgrid and ESB Specifications.
4. The Elevation of the Compound will be depicted by localized Topography such that Cut/Fill Earthworks associated with the construction of the Compound are balanced.
5. All Levels are in Malin Head O.D., unless noted otherwise.

LEGEND: -


Proposed Levels shown thus FFL0.00m

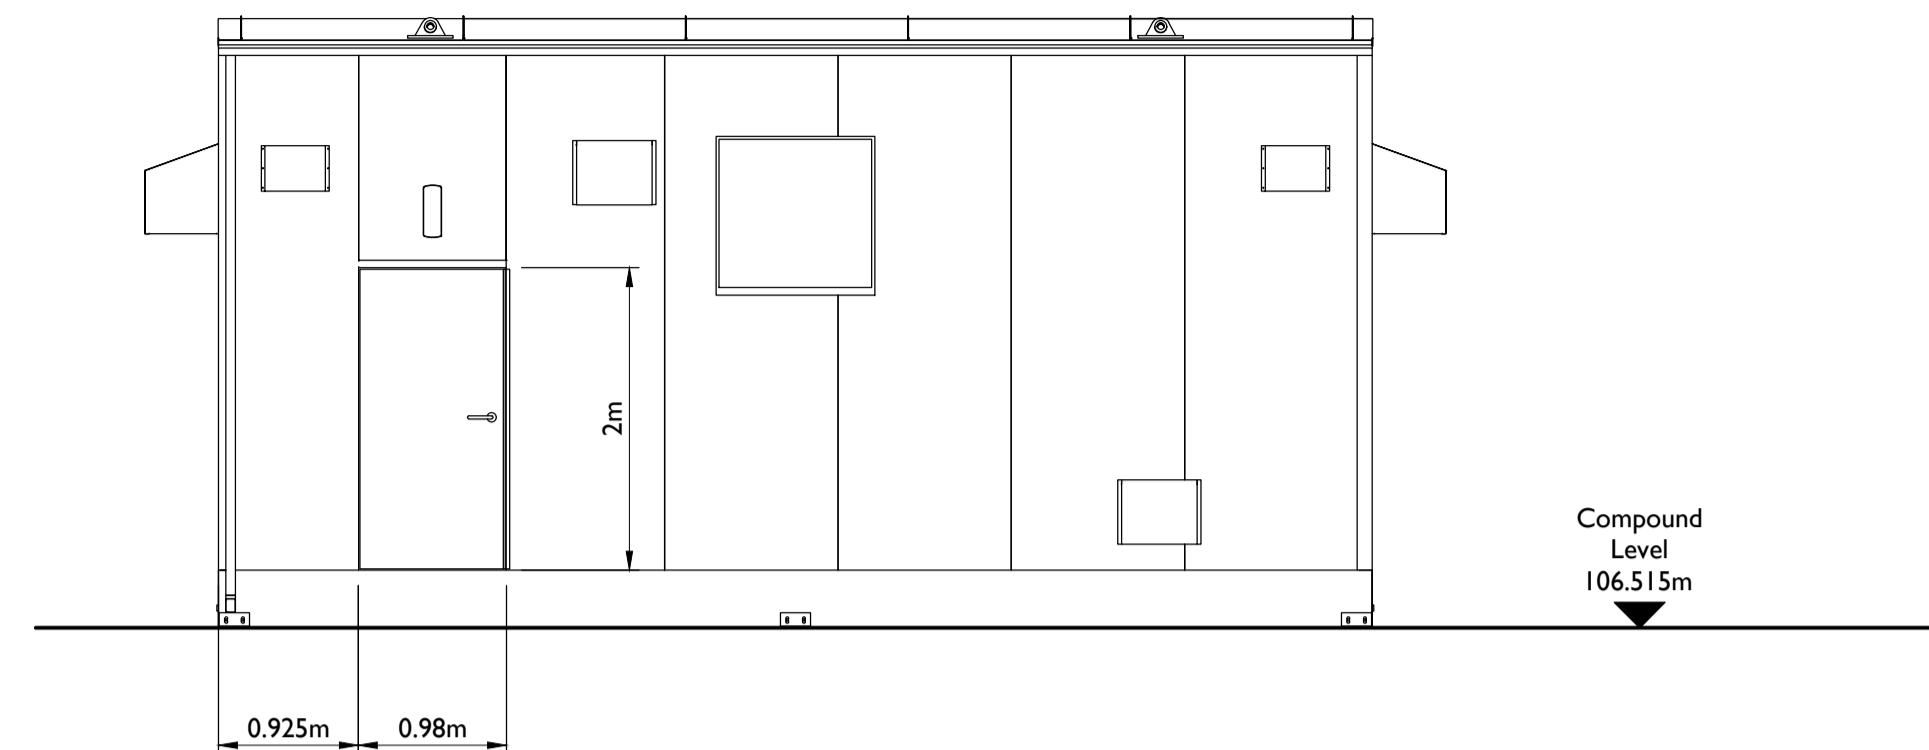


**Rear Elevation (Section View)**  
 Scale: 1:50

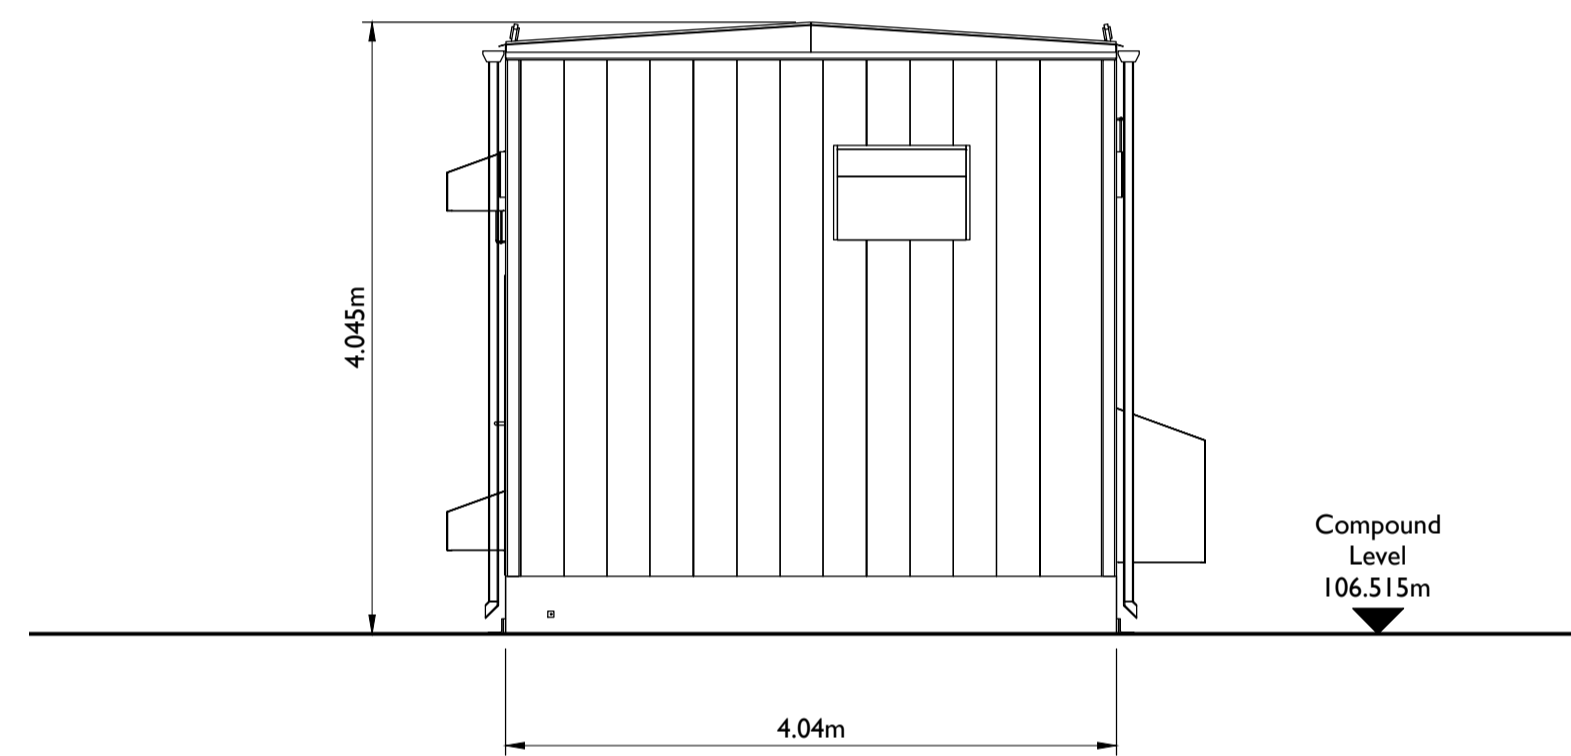


**Side Elevation (Section View)**  
 Scale: 1:50

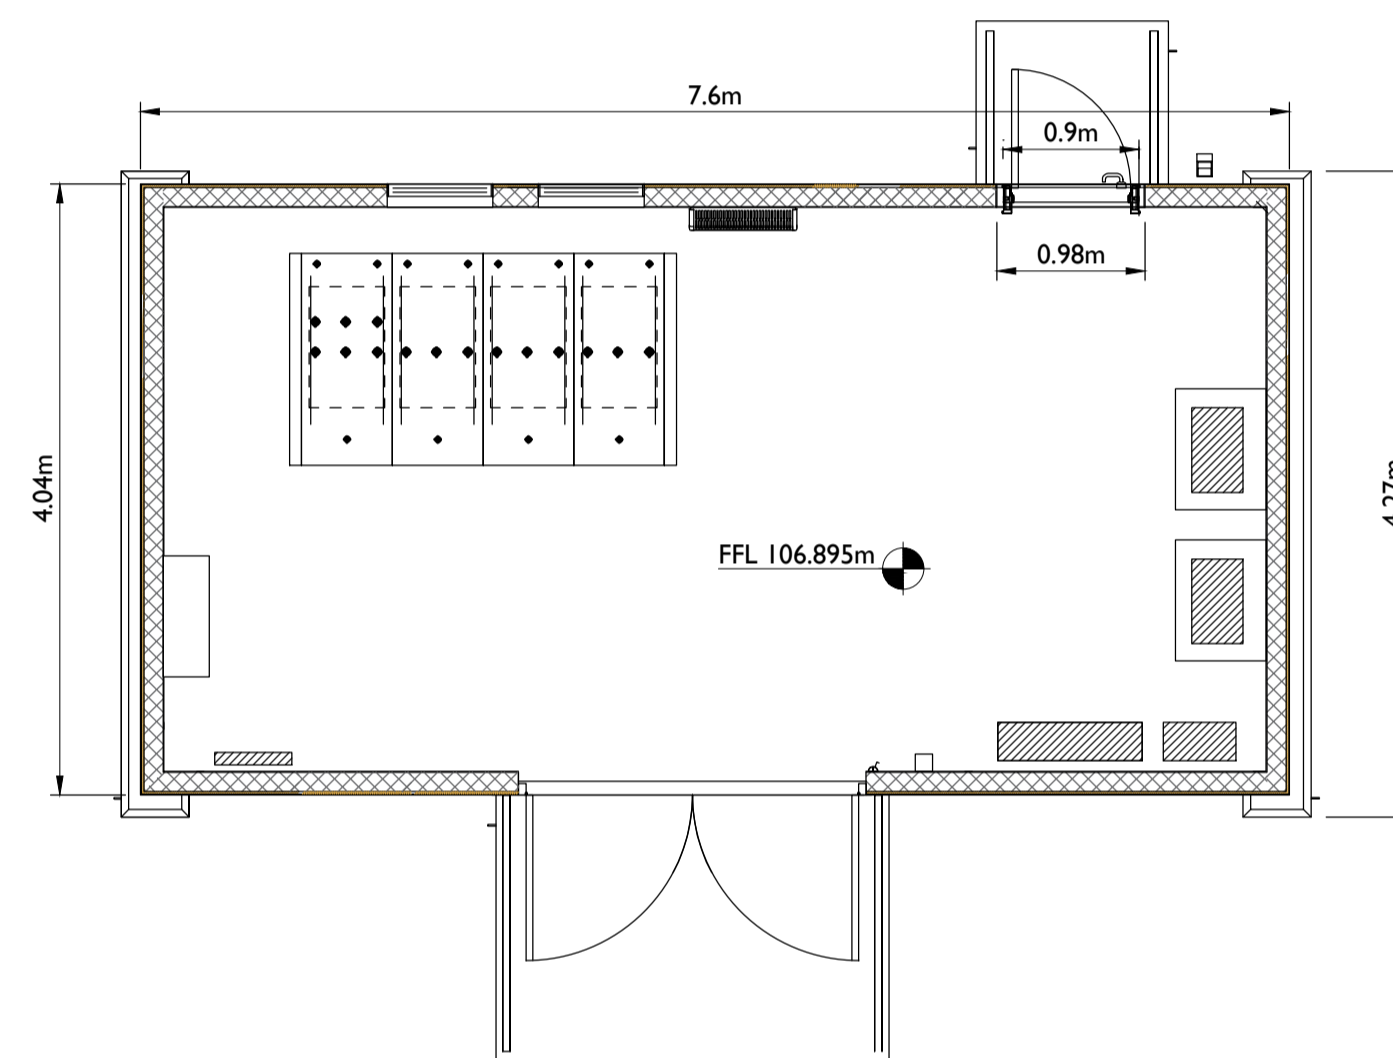

**Plan View**  
 Scale: 1:50

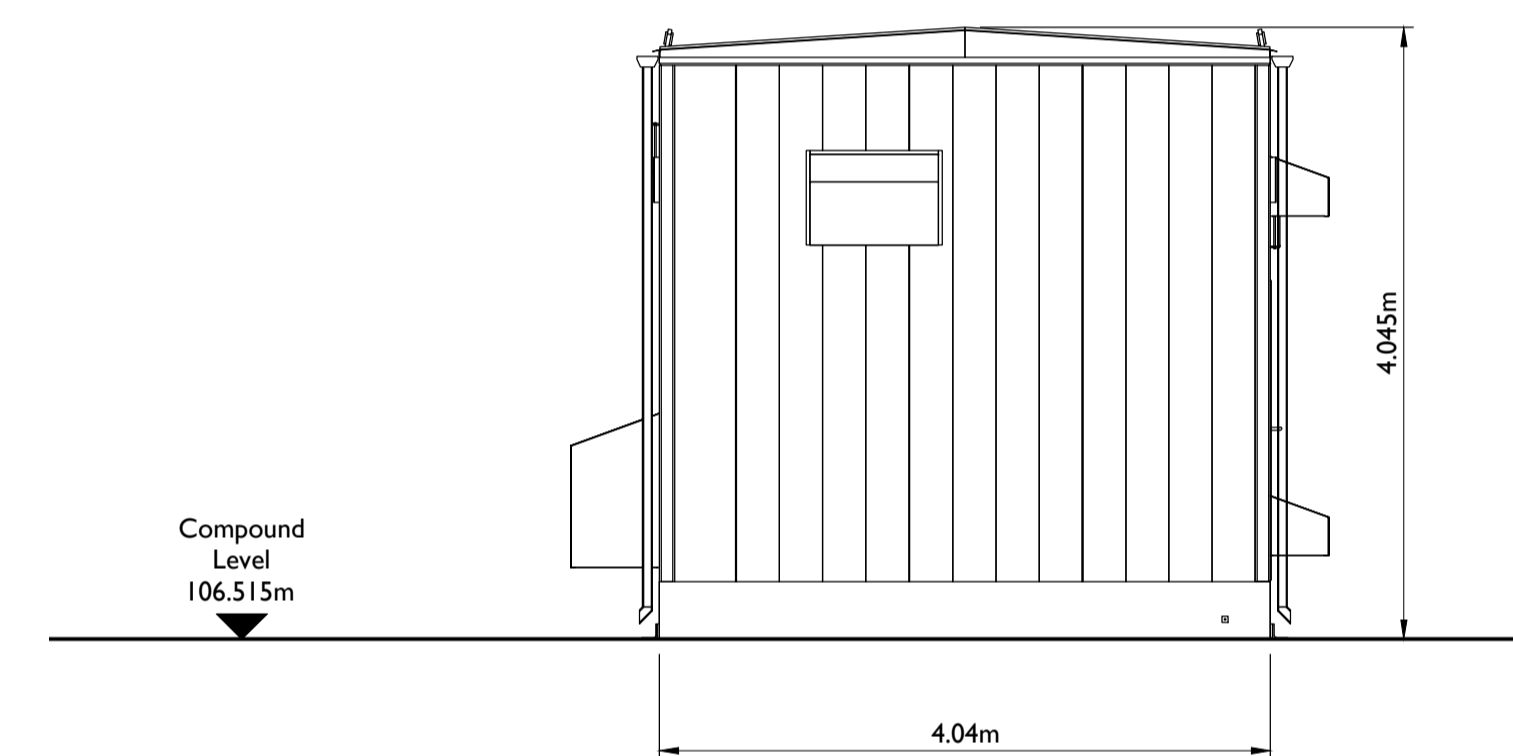

**Side Elevation (Section View)**  
 Scale: 1:50

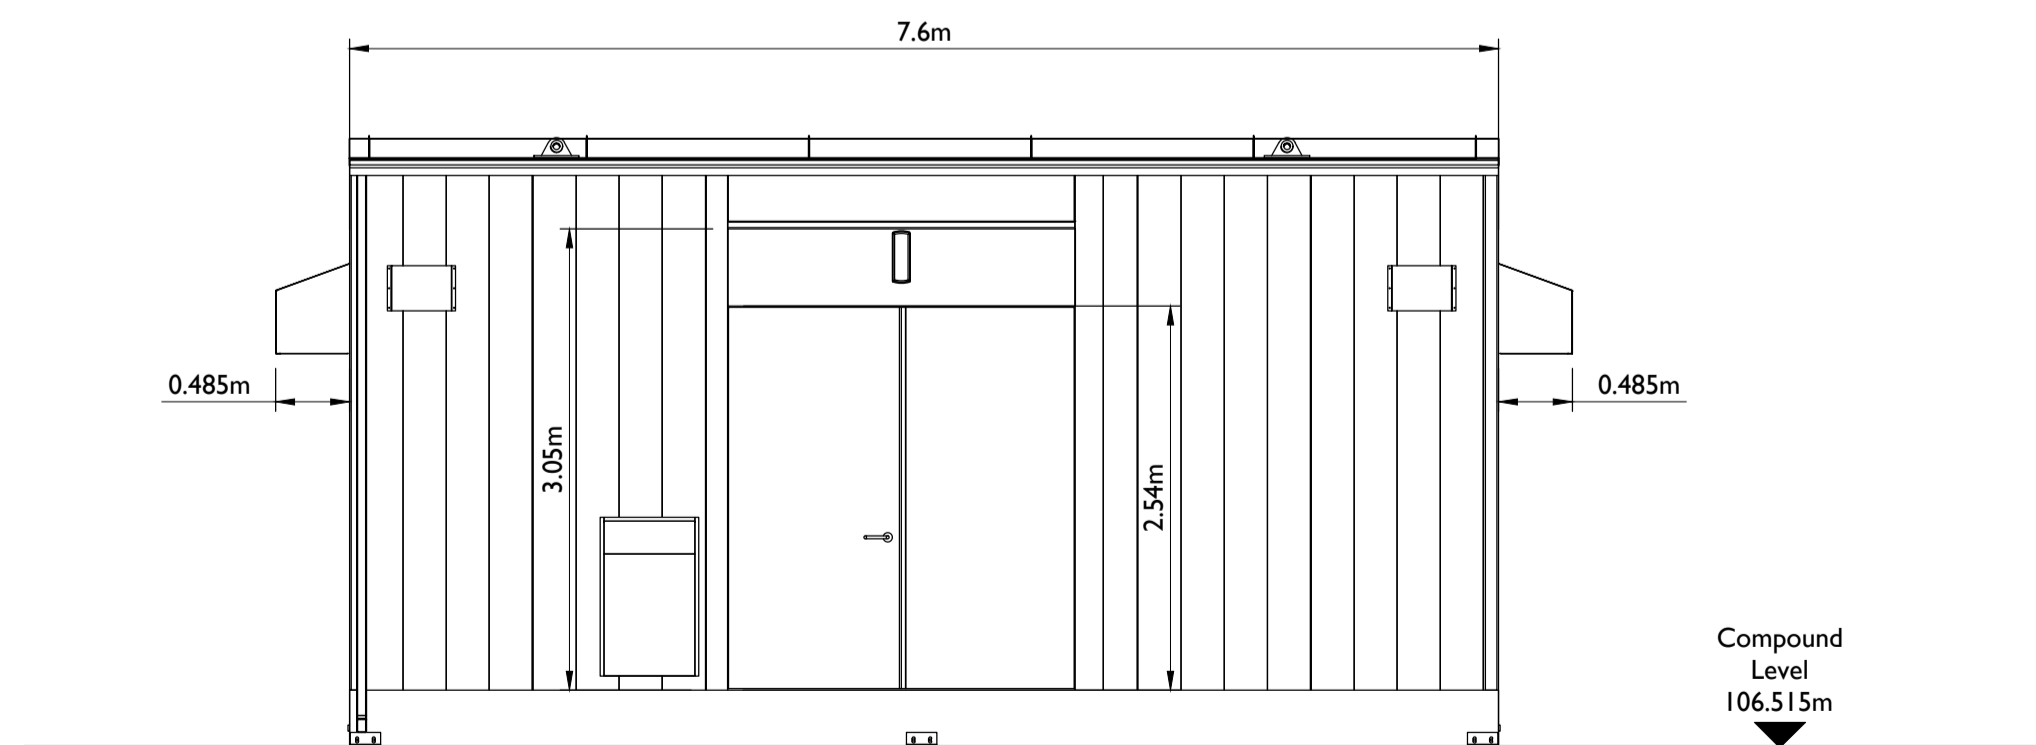

**Front Elevation (Section View)**  
 Scale: 1:50

ISSUE/REVISION

I/R	DATE	DESCRIPTION
P2	22.08.24	Issued for Planning
P1	30.05.24	Issued for Planning
I/R	DATE	DESCRIPTION

PROJECT NUMBER

05-1040

SHEET TITLE

IPP Building - Plan & Elevations & Section

SHEET NUMBER

051040-DR-103